



develotek property group	issue	date	revision	Notes This drawing represents a possible architectural design to demonstrate the potential of the site. Final design, unit mix and SEPP 65 compliance is subject to a Design Excellence process and future DA approval.	project 5 - 9 Gol Chatswood client DPG Pro
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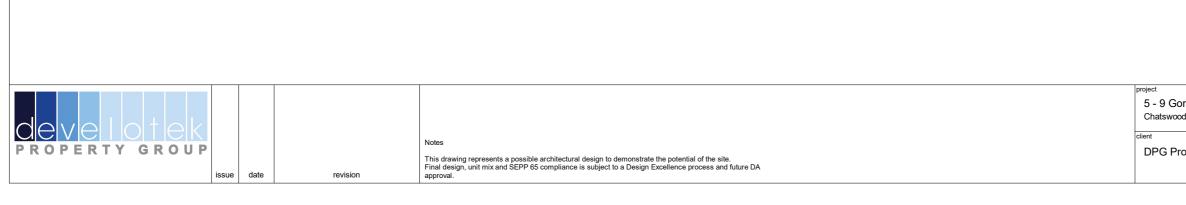
ordon Avenue od, NSW, 2067	drawing Typical Basement Plan			\bigcirc
roject 32 Pty Ltd	project no. drawn PB date	scale 1 : 250@ A1 issue	drawing no.	01




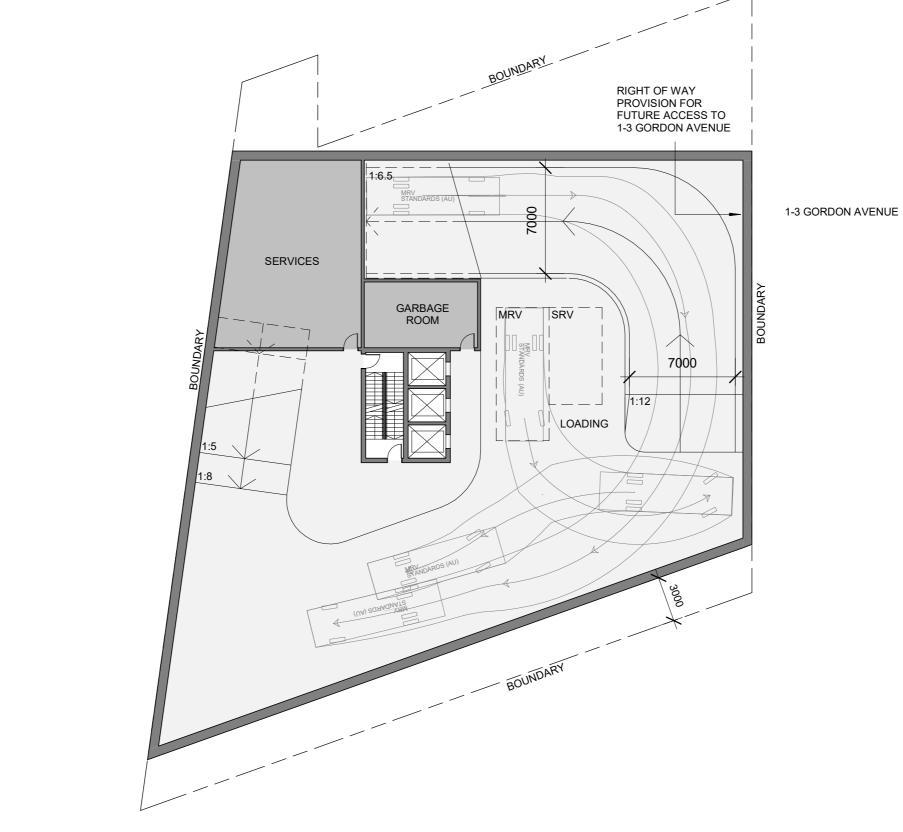

ordon Avenue od, NSW, 2067	drawing Baseme	nt 1 Plan		\bigcirc	
roject 32 Pty Ltd	project no. drawn PB date	scale 1 : 250@ A1 issue	drawing no.)2	



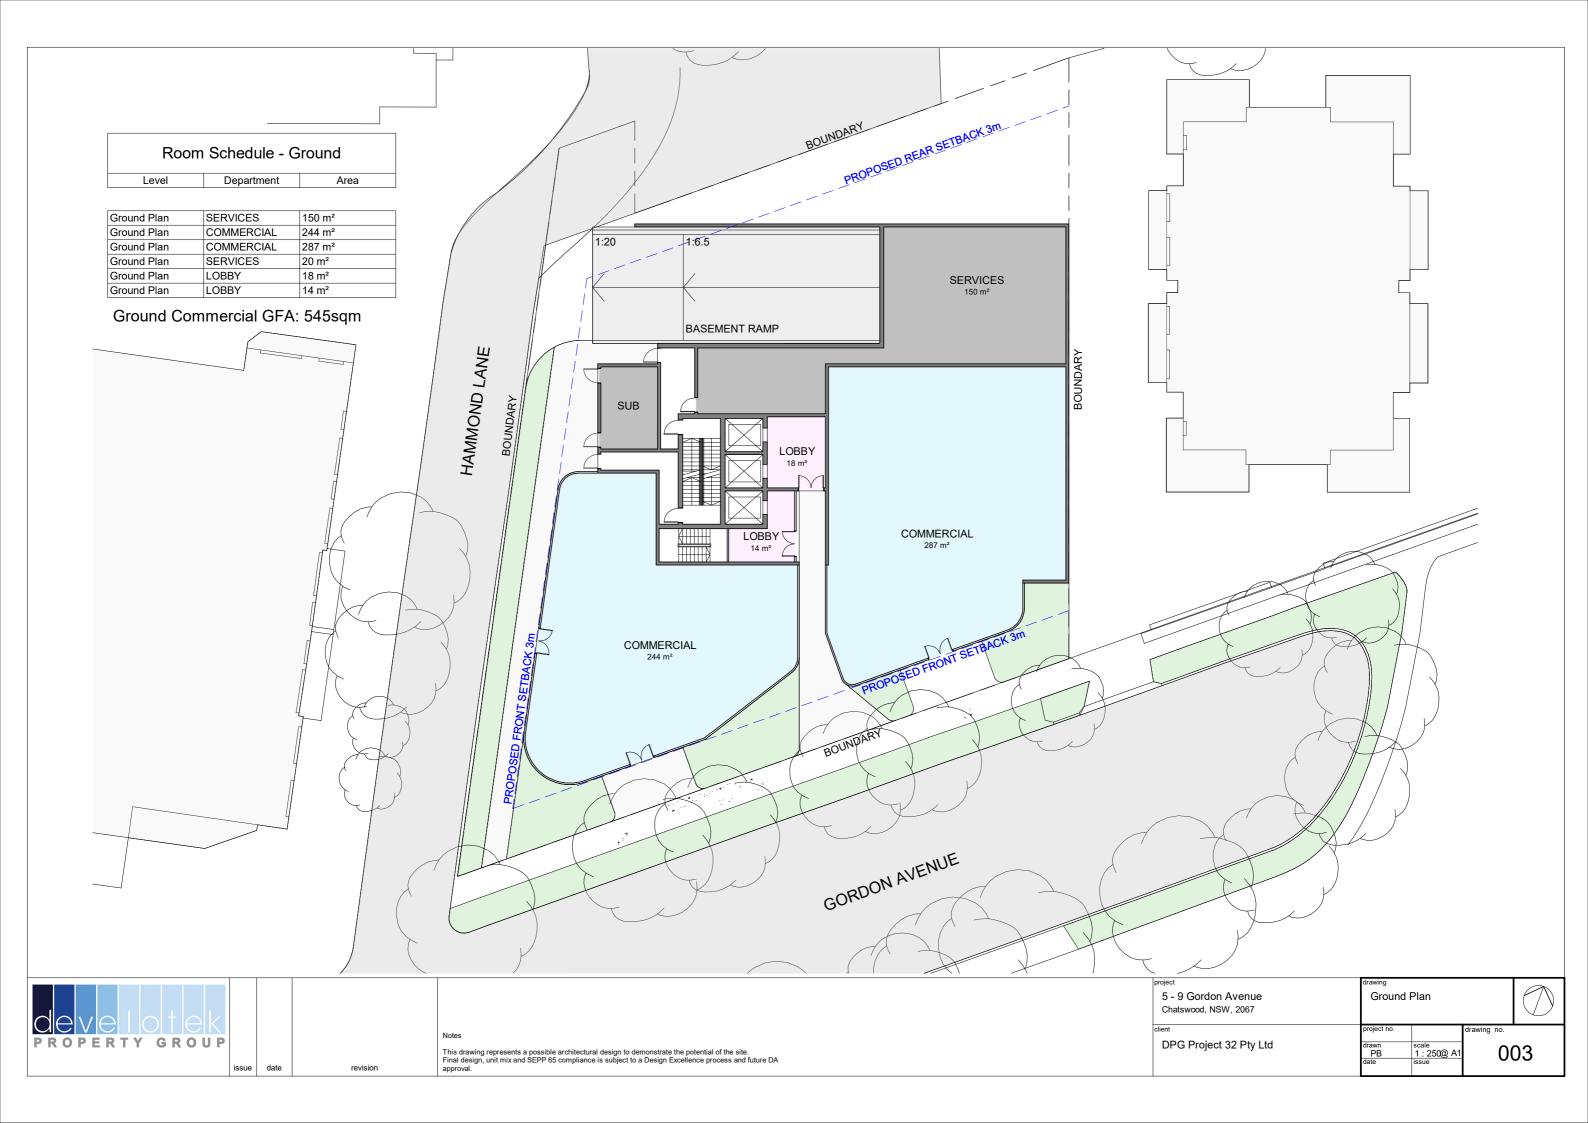


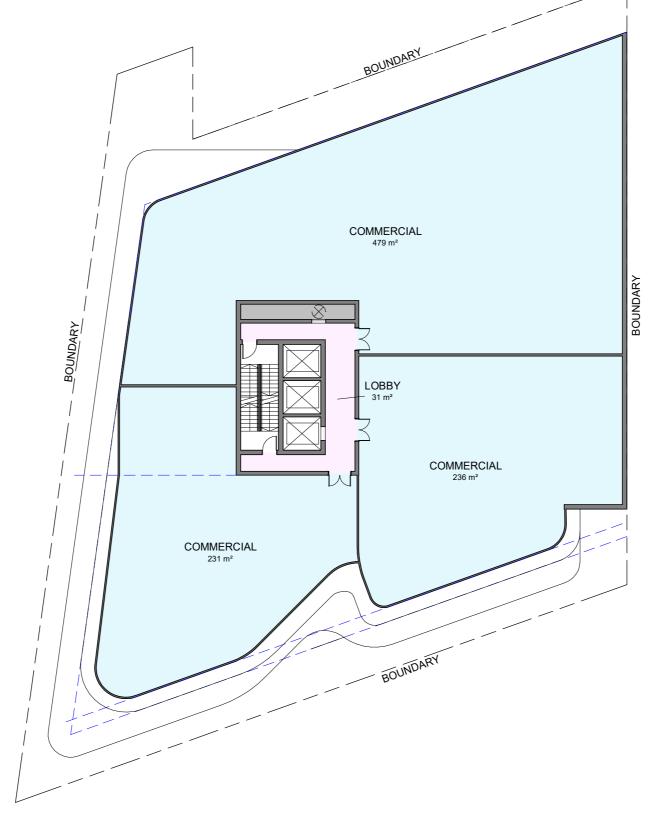

Room Schedule - Level 1					
Level	Department	Area			
Level 1 Plan	COMMERCIAL	231 m ²			
Level 1 Plan	COMMERCIAL	236 m ²			
Level 1 Plan	COMMERCIAL	479 m²			
Level 1 Plan	LOBBY	31 m ²			
Level 1 Plan	SERVICES	8 m²			


L1 Commercial GFA: 977sqm

ordon Avenue od, NSW, 2067	^{drawing} Level 1 Plan			\bigcirc
roject 32 Pty Ltd	project no. drawn PB date	scale 1 : 250@ A1 issue	drawing no.	04

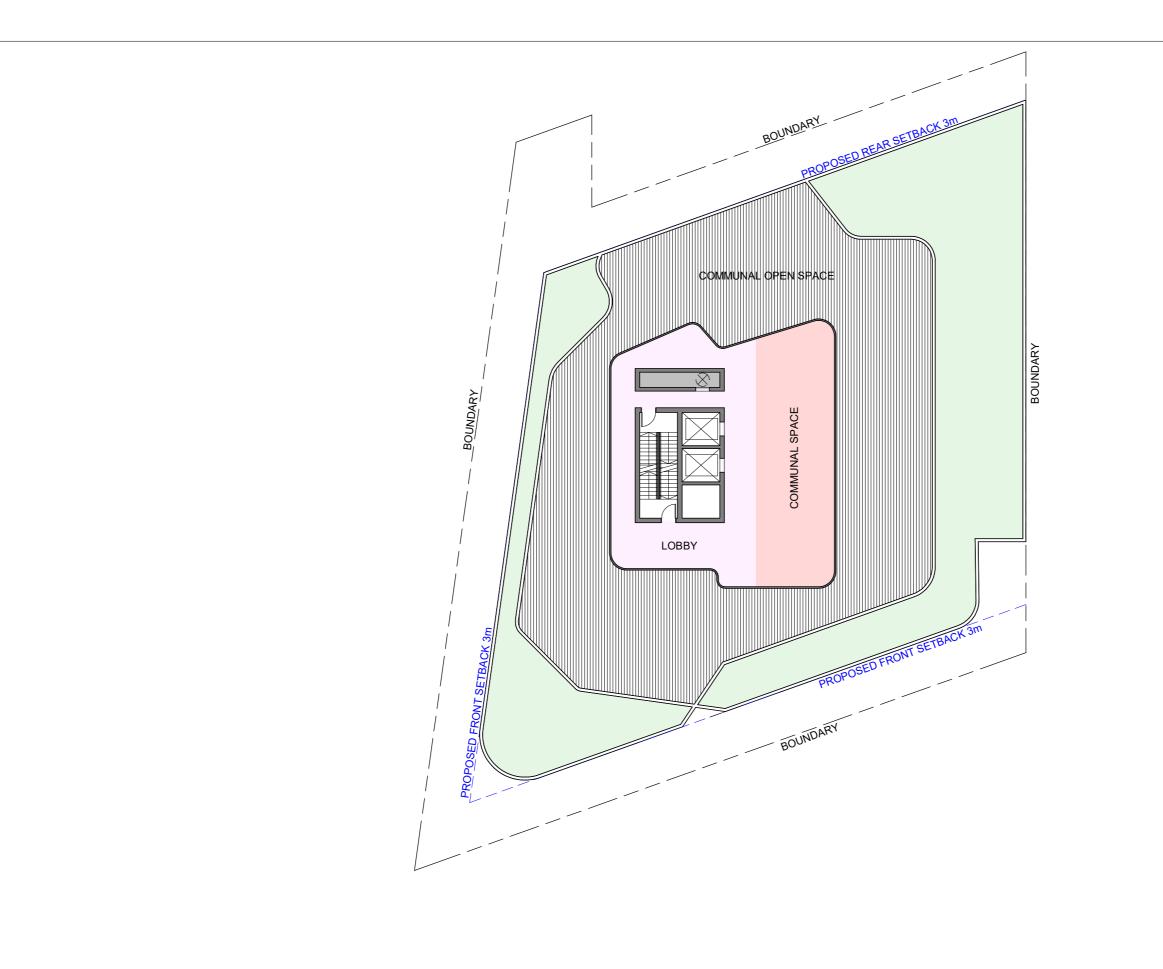



ordon Avenue od, NSW, 2067	^{drawing} Level 2 Plan			\bigcirc
roject 32 Pty Ltd	project no. drawn PB date	scale 1 : 250@ A1 issue	drawing no.)5

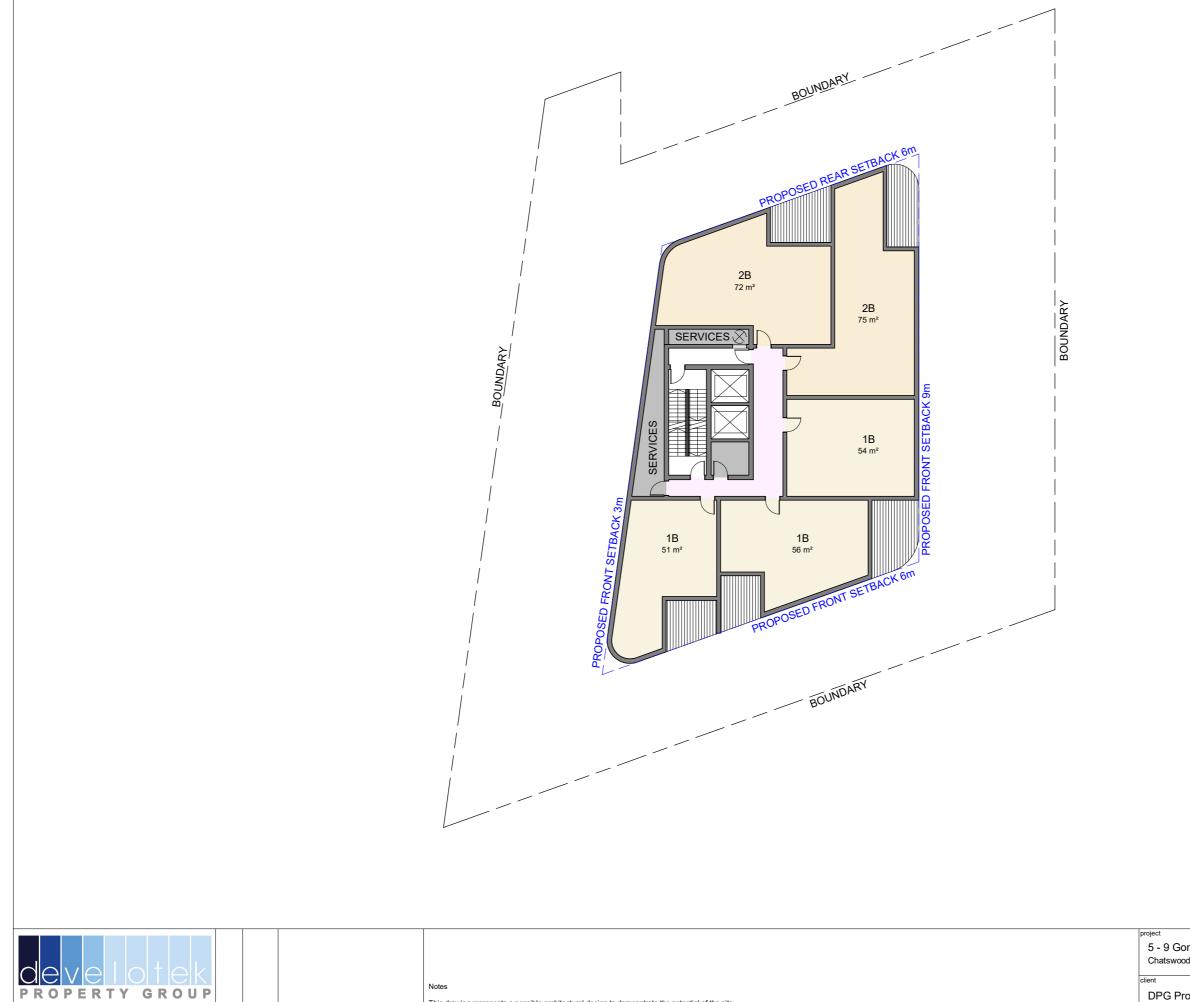

This drawing represents a possible architectural design to demonstrate the potential of the site.
Final design, unit mix and SEPP 65 compliance is subject to a Design Excellence process and future DA
approval.

issue date

revision

ordon Avenue od, NSW, 2067	^{drawing} Level 3 - Level 13 Plan		\bigcirc	
roject 32 Pty Ltd	project no. drawn Author date	scale 1 : 250@ A1 issue	drawing no.	06



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PROPERTY GROUP

date

revision

issue

This drawing represents a possible architectural design to demonstrate the potential of the site. Final design, unit mix and SEPP 65 compliance is subject to a Design Excellence process and future DA approval.

ordon Avenue od, NSW, 2067	^{drawing} Level 14	- Level 21	Plan	\bigcirc
roject 32 Pty Ltd	project no. drawn PB date	scale 1 : 250@ A1 issue	drawing no.	07





PROPERTY GROUP

date

revision

issue

This drawing represents a possible architectural design to demonstrate the potential of the site. Final design, unit mix and SEPP 65 compliance is subject to a Design Excellence process and future DA approval.

ordon Avenue od, NSW, 2067	^{drawing} Level 22 - Level 233		\bigcirc	
roject 32 Pty Ltd	project no. drawn Author date	scale 1 : 250@ A1 issue	drawing no.	



Notes

PROPERTY GROUP


date

revision

issue

This drawing represents a possible architectural design to demonstrate the potential of the site. Final design, unit mix and SEPP 65 compliance is subject to a Design Excellence process and future DA approval.

ordon Avenue od, NSW, 2067	^{drawing} Level 24	- Level 25	Plan	\bigcirc
roject 32 Pty Ltd	project no. drawn PB date	scale 1 : 250@ A1 issue	drawing no.	09

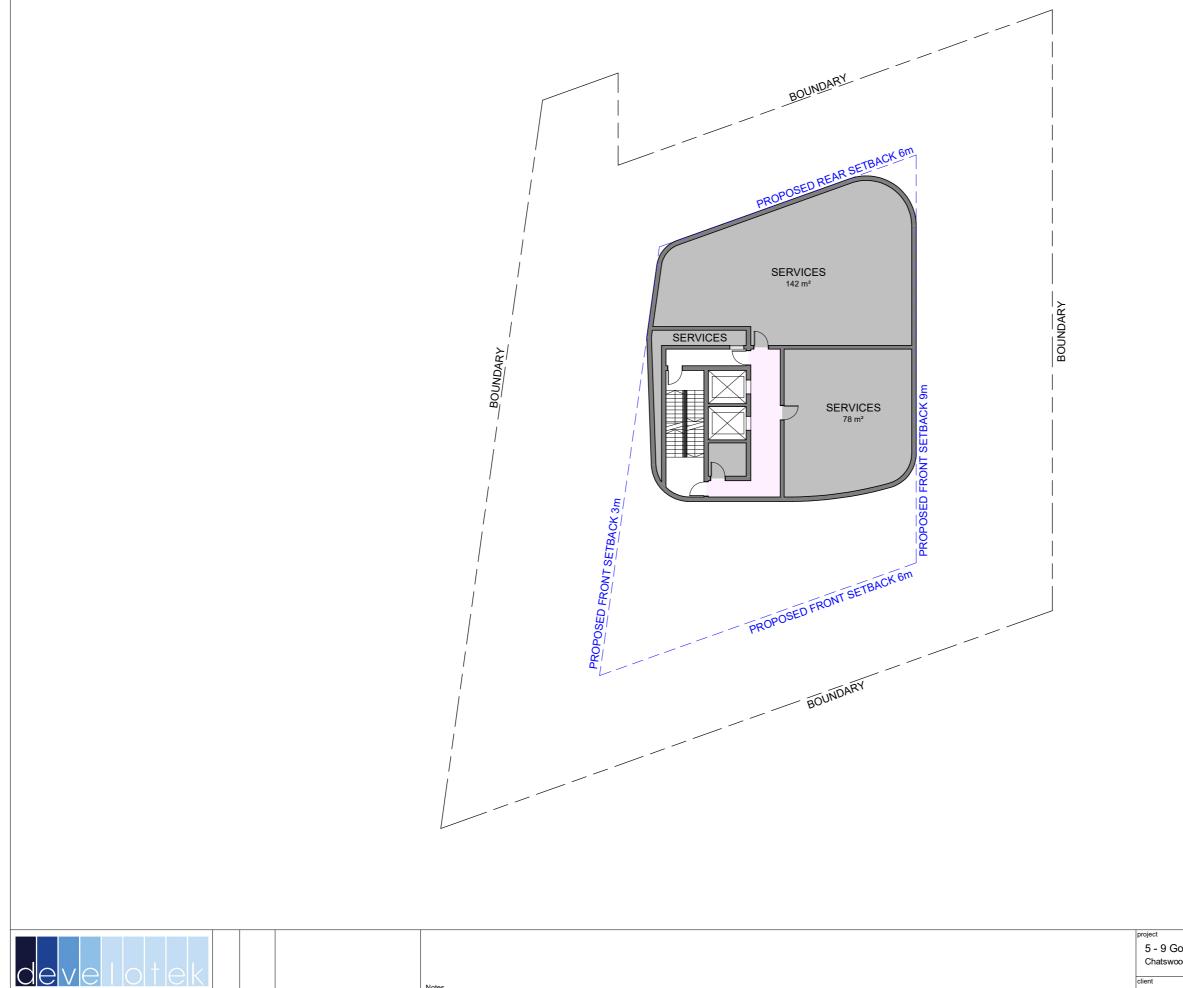

Notes

PROPERTY GROUP

date

revision

issue

This drawing represents a possible architectural design to demonstrate the potential of the site. Final design, unit mix and SEPP 65 compliance is subject to a Design Excellence process and future DA approval.

ordon Avenue od, NSW, 2067	drawing Level 27 Plan			\bigcirc
roject 32 Pty Ltd	project no. drawn Author date	scale 1 : 250@ A1 issue	drawing no.	

Building Envelope | Proposed Option 2

Planning Controls

- FSR 6:1
- Building Height: 29 storeys (under 90m)
- Mixed use:
 - GF: Retail/Commercial
 - LOI: Residential/Commercial
 - L02-29: Residential
- Communal open space at L02
- Site setbacks: refer to indicative floor plans

Pros

Building envelope based on utilizing maximised building height of 90m *

Design Principles

- Floor plate size based on max FSR 6:1 *
- Activated Gordon Ave. and part of Hammond Lane frontage with retail/ commercial use at the podium level, residential tower above
- Basement car park/deliveries/waste
 collection off Hammond Lane
- Hammond Lane proposed to be widened to accommodate two way traffic
- Improvement to Public Domain in Gordon Ave. and Hammond Lane

- Elegant tower form of slender proportion
- Adequate urban response to public domain and human scale by creating two storey-high podium and recessed tower form above
- Excellent view opportunities in current urban context maximised due to full utilisation of permissible* height limit
- Additional podium setback to Gordon Ave. enables outdoor seating and better activation.
- Additional podium setback to Hammond Lane delivers strategic pedestrian connection, vehicular access and improved activation of corner.
- Reduces vehicular crossings on Gordon Ave.

Cons


- Inefficient floor plate allowing only for 2-3 units per floor
- Taller tower casting longer shadows, however not compromising ADG compliance to existing units
- View opportunities would be reduced when all neighbouring sites are developed with high-rise density
- Angular floor plate is not practical for high quality apartment layouts
- Small floor plate results in proportionally higher area dedicated to core & services

Summary


Option 2 maximises building height achieving permissible limit of 90m. Distribution of allowable GFA across all floors would not be economical resulting only in 2-3 units per floor.


Building form appears elegantly slender with attractive overall proportions. Generous tower setbacks create sufficient space that could be utilised as communal open space, landscaped area on top of the podium.

While the form is visually very slender, this proposal is not viable due to the angular geometry of the site and resulting small floor plate.

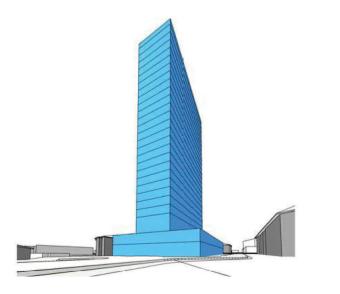

Hammond Lane towards Gordon Ave.

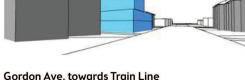

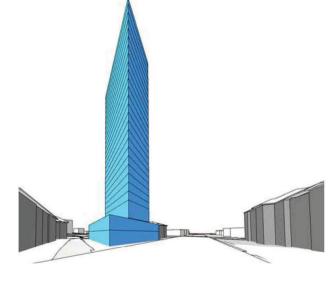

Corner of Gordon Ave. & Hammond Lane



Design | Landscape Concept



Gound Floor plan @ 1:250

K

N

Design | Landscape Concept



Level 02 Floor plan @ 1:250

N